Issued For:

CLIENT REVIEW & COORDINATION

Project Description:

Proposed New Double Storey Dwelling & Pool Located At:

Lot 2 in DP 517050 No.193 William Street, Bankstown. NSW



GENERAL NOTES:

- STORM WATER DRAINAGE TO STREET STORMWATER SYSTEM & THE BASIX REPORT
 SEWER DRAINAGE & WASTE WATER TO SYDNEY WATER SEWER MAIN
 SEDIMENT CONTROL BARRIER TO COUNCIL SPECIFICATIONS DURING CONSTRUCTION
 SURVEY LEVELS & CONTOURS TO AUSTRALIAN HEIGHT DATUM OR AS INDICATED ON SURVEY PLAN +-100mm
 - 5. TERMITE CONTROL CHEMICAL OR PHYSICAL BARRIER TO BE INSTALLED IN ACCORDANCE WITH AS3660
 - 6. VERIFY ALL DIMENSIONS, LEVELS & EXISTING CONDITION ON SITE PRIOR TO COMMENCEMENT OF WORK
 - 7. ALL WORK & MATERIALS TO COMPLY WITH THE BUILDING CODE OF AUSTRALIA & RELEVANT STANDARDS AUSTRALIA CODES
 - 8. FIGURED DIMENSIONS TAKE PREFERENCE TO SCALE 9. ALL DIMENSIONS IN MILLIMETRES U.N.O.
 - 10. DRIVEWAY GRADIENT TO COMPLY WITH COUNCIL REGULATIONS
 11. DROP EDGE BEAMS TO ENGINEERS DETAILS IF REQUIRED
 - 12. ALL STRUCTURAL BEAM SIZES & DETAILS TO ENGINEERS SPECIFICATIONS
 13. ANY RETAINING WALL REQUIRED WILL BE CONSTRUCTED FROM COPPER LOGS OR
- MASONRY NOT EXCEEDING 600mm HIGH

 14. AN ALL WEATHER ACCESS CONSISTING OF RECYCLED CONCRETE WILL BE PROVIDED
- I. AN ALL WEATHER ACCESS CONSISTING OF RECYCLED CONCRETE WILL BE PROVIDED

 15. PERMANENT DRIVEWAY TO BE REINFORCED CONCRETE

 16. ANY CONCRETE PATHS TO BE REINFORCED CONCRETE
- 17. SURFACE DRAINS WILL BE INCORPORATED IN THE LANDSCAPING TO REMOVE SURFACE WATER FROM GRASSED & CONCRETE AREAS
- 18. AGRICULTURAL DRAINS WILL BE APPLIED BEHIND ALL RETAINING WALLS & WILL BE CONNECTED INTO THE STORMWATER LINE
 - 19. SURVEY DATA OBTAINED FROM SYDNEY REGISTERED SURVEYORS PLAN REFERENCE 4980
- 20. CHILD PROOF SCREENS MUST BE FITTED TO FIRST FLOOR BEDROOM WINDOWS WHERE THE SILL IS LESS THAN 1.7M ABOVE FLOOR LEVEL, OR WINDOW OPENINGS TO BE RESTRICTED TO 125mm, IN ACCORDANCE WITH CLAUSE 3.9.2.6 OF THE NCC VOLUME 2


AUSTRALIAN STANDARD CODES

AS 1288 Glazing
AS 1684.4 Timber Framing
AS 1728.1 Timber Structures Code
AS 2857 Termite Protection
AS 2878.1 Residential Slabs & Footings
AS 3500 National Plumbing & Drainage
AS 3600 Concrete Structures
AS 3700 Masonry in Buildings
AS 3786 Smoke Alarms
AS 4100 Steel Structures


			15	Electrical Plans
			14	Landscape Plan
			13	Kitchen Elevations
			12	Wet Area Details
			11	Roof Plan, Section & Schedule
			10	Elevations
			9	Elevations
			8	First Floor Plan
			7	Ground Floor Plan
			6	Slab Plan
			5	Sedimentaion & Waste Plan
			4	Site Analysis Plan
			3	Site Plan
			2	Basix / Nathers
1	04.11.22	Client Review	1	Cover Sheet
Rev	Date	Amendment	Sheet	Description


A JR Design & Drafting	Issue Amendment	Date: North:		Proposed:	Drawing Title:	Revision:
Residential Design & Drafting Services	1 Client Review	04.11.22		New Double Storey Dwelling & Pool	Cover Page	1
Phone: (02) 9757 - 4002 Fax: (02) 9757 - 4003 Email: jr.design.drafting@gmail.com Address: Suite 304 No. 447 Victoria Street, Wetherill Park. NSW 2164				Location: Lot 2 in DP 517050 No.193	L.G.A	Design: CALDORA 40
1. All work to be carried out in accordance with the requirements of the Building Code of Australia and the relevant loca authority. 2. All timber framing to be carried out to the requirements of the Standards (as 1684) as a minimum. 3.4 neither framing to be carried out to the requirements of Australian Standards (as 1684) as a minimum.			VOGUÉ/HOMES	William Street, Bankstown .NSW	Bankstown Council	VH Job No: 9101-22
Structural Engineer to check, detail and centry brickwork to gaze area with a height greater than 3000mm between horizontal supports. All brickwork to be constructed in accordance with the requirements of the Building Code of Australia.			Copyright: This plan is the exclusive property of Vogue Homes. and must not be used, reproduced or copied wholly in any way without	Client:	Facade: FREMANTLE Date 04.11.22	JR Job No:
d. Connot paris in trackboars or protection in accordance within the register exhibition is excitably Cooper or Australia. 7. Doowney openings with inward opening doors to room containing follets which are closer than 1200mm to the tollet are not be fitted with hinges to allow the door to be removed from the outside when the door is closed.			permission	Joseph Anthony Latorre & Marilyn Nguyen	Scale 1:25.81 Sheet 1 of 15	VH2249




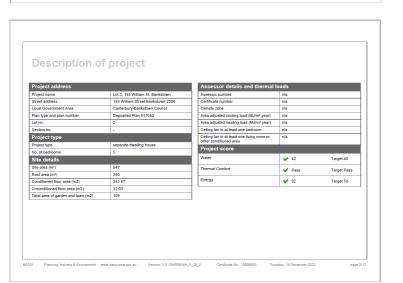


BASIX Planning, Industry & Environment www.basix.nsw.gov.au Version: 3.0 / DARWINIA_3_20_0 Certificate No: 1350650S Thursday, 15 December 2022 page 1/12

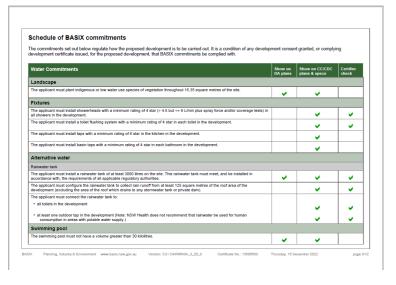

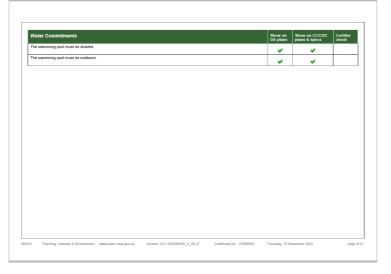

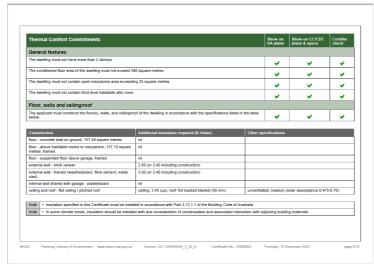

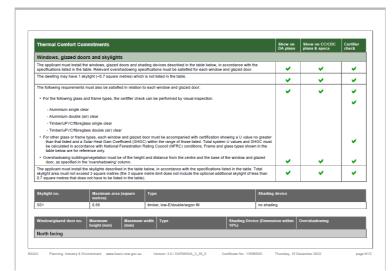

Windowlglazed door no.	Maximum height (mm)	Maximum width (mm)	Type	Shading Device (Dimension within 10%)	Overshadowing
ASW(Ensuite)	600	610	U-value: 4.9, SHGC: 0.297 - 0.363 (aluminium, double (air), Lo-Tsol Low-e/clear)	none	>4 m high, 2-5 m away
ASW(Media)	1030	2700	U-value: 4.9, SHGC: 0.297 - 0.363 (aluminium, double (air), Lo-Tsol Low-e/clear)	none	>4 m high, 2-5 m away
ASW1(Living)	2100	970	U-value: 4.9, SHGC: 0.297 - 0.363 (aluminium, double (air), Lo-Tsol Low-e/clear)	none	>4 m high, 2-5 m away
ASW2(Living)	2100	970	U-value: 4.9, SHGC: 0.297 - 0.363 (aluminium, double (air), Lo-Tsol Low-e/clear)	none	>4 m high, 2-5 m away
FG1(Living)	600	4300	U-value: 4.9, SHGC: 0.297 - 0.363 (aluminium, double (air), Lo-Tsol Low-e/clear)	none	>4 m high, 2-5 m away
ASD(Dining)	2400	2700	U-value: 4.9, SHGC: 0.297 - 0.363 (aluminium, double (air), Lo-Tsol Low-e/clear)	eave 5040 mm, 1270 mm above head of window or glazed door	>4 m high, 2-5 m away
FG1(Dining)	600	2800	U-value: 4.9, SHGC: 0.297 - 0.363 (aluminium, double (air), Lo-Tsol Low-e/clear)	eave 5040 mm, 670 mm above head of window or glazed door	>4 m high, 2-5 m away
ASW(Sitting)	1600	2400	U-value: 4.9, SHGC: 0.297 - 0.363 (aluminium, double (air), Lo-Tsol Low-e/clear)	eave 600 mm, 150 mm above head of window or glazed door	>4 m high, 2-5 m away
ASW(Bath)	1030	1810	U-value: 4.9, SHGC: 0.297 - 0.363 (aluminium, double (air), Lo-Tsol Low-e/clear)	eave 600 mm, 150 mm above head of window or glazed door	>4 m high, 2-5 m away
ASW1(BR1)	1030	3000	U-value: 4.9, SHGC: 0.297 - 0.363 (aluminium, double (air), Lo-Tsol Low-e/clear)	eave 600 mm, 150 mm above head of window or glazed door	>4 m high, 2-5 m away
East facing					
ASD(Living)	2400	3700	U-value: 4.9, SHGC: 0.297 - 0.363 (aluminium, double (air), Lo-Tsol Low-e/clear)	eave 3480 mm, 1270 mm above head of window or glazed door	not overshadowed

Windowlglazed door no.	Maximum height (mm)	Maximum width (mm)	Туре	Shading Device (Dimension within 10%)	Overshadowing
ASD(Dining)	2100	4000	U-value: 4.9, SHGC: 0.297 - 0.363 (aluminium, double (air), Lo-Tsol Low-e/clear)	eave 600 mm, 1270 mm above head of window or glazed door	not overshadowed
FG2(Living)	600	3700	U-value: 4.9, SHGC: 0.297 - 0.363 (aluminium, double (air), Lo-Tsol Low-e/clear)	eave 3480 mm, 670 mm above head of window or glazed door	not overshadowed
FG2(Dining)	600	4000	U-value: 4.9, SHGC: 0.297 - 0.363 (aluminium, double (air), Lo-Tsol Low-e/clear)	eave 600 mm, 670 mm above head of window or glazed door	not overshadowed
ASW2(BR1)	1600	3000	U-value: 4.9, SHGC: 0.297 - 0.363 (aluminium, double (air), Lo-Tsol Low-e/clear)	eave 600 mm, 150 mm above head of window or glazed door	not overshadowed
ASW3(BR1)	1030	2400	U-value: 4.9, SHGC: 0.297 - 0.363 (aluminium, double (air), Lo-Tsol Low-e/clear)	eave 600 mm, 150 mm above head of window or glazed door	not overshadowed
ASW(Ens1)	1030	2400	U-value: 4.9, SHGC: 0.297 - 0.363 (aluminium, double (air), Lo-Tsol Low-elclear)	eave 600 mm, 150 mm above head of window or glazed door	not overshadowed
South facing					
ASD(Laundry)	2400	1570	U-value: 4.9, SHGC: 0.297 - 0.363 (aluminium, double (air), Lo-Tsol Low-e/clear)	none	2-4 m high, 5-8 m away
AFW(WIP)	600	1700	U-value: 4.9, SHGC: 0.297 - 0.363 (aluminium, double (air), Lo-Tsol Low-e/clear)	none	2-4 m high, 5-8 m away
AFW(Kitchen)	600	3400	U-value: 4.9, SHGC: 0.297 - 0.363 (aluminium, double (air), Lo-Tsol Low-elclear)	none	2-4 m high, 5-8 m away
ASW(BR4)	1600	2700	U-value: 4.9, SHGC: 0.297 - 0.363 (aluminium, double (air), Lo-Tsol Low-e/clear)	eave 600 mm, 150 mm above head of window or glazed door	2-4 m high, 5-8 m away
West facing					
AAW(Guest)	2100	2300	U-value: 4.9, SHGC: 0.297 - 0.363 (aluminium, double (air), Lo-Tsol Low-e/clear)	none	not overshadowed

Windowiglazed door no.	Maximum height (mm)	Maximum width (mm)	Туре	Shading Device (Dimension within 10%)	Overshadowing
ASD(BR3)	2400	2700	U-value: 4.9, SHGC: 0.297 - 0.363 (aluminium, double (air), Lo-Tsol Low-e/clear)	eave 600 mm, 150 mm above head of window or glazed door	not overshadowed
AFW(Void)	1800	2400	U-value: 4.9, SHGC: 0.297 - 0.363 (aluminium, double (air), Lo-Tsol Low-e/clear)	eave 600 mm, 150 mm above head of window or glazed door	not overshadowed
AAW(BR2)	2100	2300	U-value: 4.9, SHGC: 0.297 - 0.363 (aluminium, double (air), Lo-Tsol Low-e/clear)	eave 600 mm, 150 mm above head of window or glazed door	not overshadowed

Energy Commitments	Show on DA plans	Show on CC/CDC plans & specs	Certifier check
Hot water			
The applicant must install the following hot water system in the development, or a system with a higher energy rating: gas instantaneous with a performance of 6 stars.	-	~	-
Cooling system			
The applicant must install the following cooling system, or a system with a higher energy rating, in at least 1 living area: 1-phase irronditioning; Energy rating: EER < 2.5		~	-
The applicant must install the following cooling system, or a system with a higher energy rating, in at least 1 bedroom: airconditioning lucting only; Energy rating: n/a		~	v
Heating system			
The applicant must install the following heating system, or a system with a higher energy rating, in at least 1 living area: 1-phase irronditioning; Energy rating: EER < 2.5		~	v
The applicant must install the following heating system, or a system with a higher energy rating, in at least 1 bedroom: airconditioning lucting only; Energy rating: n/a		•	-
/entilation			
The applicant must install the following exhaust systems in the development:			
At least 1 Bathroom: individual fan, ducted to façade or roof; Operation control: interlocked to light		•	v
Kitchen: individual fan, ducted to façade or roof; Operation control: interlocked to light		•	-
Laundry: individual fan, ducted to façade or roof; Operation control: interlocked to light		•	-
Artificial lighting			
The applicant must ensure that the "primary type of artificial lighting" is fluorescent or light emitting diode (LED) lighting in each of the sillowing rooms, and where the word "dedicated" appears, the fittings for those lights must only be capable of accepting fluorescent or ghit emitting diode (LED) lamps:			
at least 5 of the bedrooms / study; dedicated			
at least 3 of the living / dining rooms; dedicated			
the kitchen; dedicated		✓	-


Energy Commitments	Show on DA plans	Show on CC/CDC plans & specs	Certifier check
all bathrooms/toilets; dedicated			- J
the laundry, dedicated			15
all hallways; dedicated		j	0
latural lighting			
he applicant must install a window and/or skylight in the kitchen of the dwelling for natural lighting.		~	- V
he applicant must install a window and/or skylight in 3 bathroom(s)/toilet(s) in the development for natural lighting.	-	~	-
Swimming pool			
he applicant must install the following heating system for the swimming pool in the development (or alternatively must not install any eating system for the swimming pool): electric heat pump		~	
he applicant must install a timer for the swimming pool pump in the development.		~	
Alternative energy			
The applicant must install a photovoltaic system with the capacity to generate at least 6 peak kilowatts of electricity as part of the evelopment. The applicant must connect this system to the development's electrical system.	-	~	-
Other			
he applicant must install a gas cooktop & electric oven in the kitchen of the dwelling.		~	
the applicant must construct each refrigerator space in the development so that it is "well ventilated", as defined in the BASIX efinitions.		~	
he applicant must install a fixed outdoor clothes drying line as part of the development.			

In these	commitments, "applicant" m	eans the person carrying	out the development.			
Commitments identified with a 📦 in the "Show on DA plans" column must be shown on the plans accompanying the development application for the proposed development (if a						
development application is to be lodged for the proposed development).						
Commitments identified with a 🚅 in the "Show on CC/CDC plans and specs" column must be shown in the plans and specifications accompanying the application for a construction						
certifica	ite / complying development of	certificate for the proposed	development.			
Commit	tments identified with a 🤳 in	the "Certifier check" colun	nn must be certified by a certifying aut	hority as having been fulfilled, b	efore a final occupation certificate(either	interim or
final) fo	r the development may be iss	sued.				
DK I						
	rianning, industry & Environmen	www.basix.nsw.gov.au	Version: 3.0 / DARWINIA_3_20_0	Certificate No.: 1350650S	Thursday, 15 December 2022	page 12/12

JR Design & Drafting	Issue	Amendment	Date:	N
I I I I I I I I I I I I I I I I I I I	1	Client Review	04.11.22	ı
Residential Design & Drafting Services				ı
Phone: (02) 9757 - 4002 Fax: (02) 9757 - 4003				
Email: jr.design.drafting@gmail.com Address: Suite 304 No. 447 Victoria Street, Wetherill Park. NSW 2164				
General Notes: 1. All work to be carried out in accordance with the requirements of the Building Code of Australia and the relevant local authority.				
 All timber framing to be carried out to the requirements of Australian Standards (as 1684) as a minimum. All reinforced concrete, steel beams including supports, and nominated beams including supports to Engineer's details. 				ı
 Structural Engineer to check, detail and certify brickwork to garage area with a height greater than 3000mm between horizontal supports. 				ı
 All brickwork to be constructed in accordance with the requirements of the Building Code of Australia. Control joints in brickwork to be provided in accordance with the requirements of the Building Code of Australia. Doorway openings with inward opening doors to room containing tolders which are closer than 1200mm to the toilet 				
are to be fitted with				ı



	Proposed:	Drawing Title:			Revision:
	New Double Storey Dwelling & Pool	Basix Commitm	nents		Design:
	Location.	L.G.A			CALDORA 40
5	Lot 2 in DP 517050 No.193 William Street, Bankstown .NSW	Bankstov	vn Cou	ıncil	VH Job No:
	Client:	Facade : FREMANTLE	Date	04.11.22	9101-22
ut	Joseph Anthony Latorre & Marilyn Nguyen	Scale	Sheet	2 of 15	JR Job No: VH2249

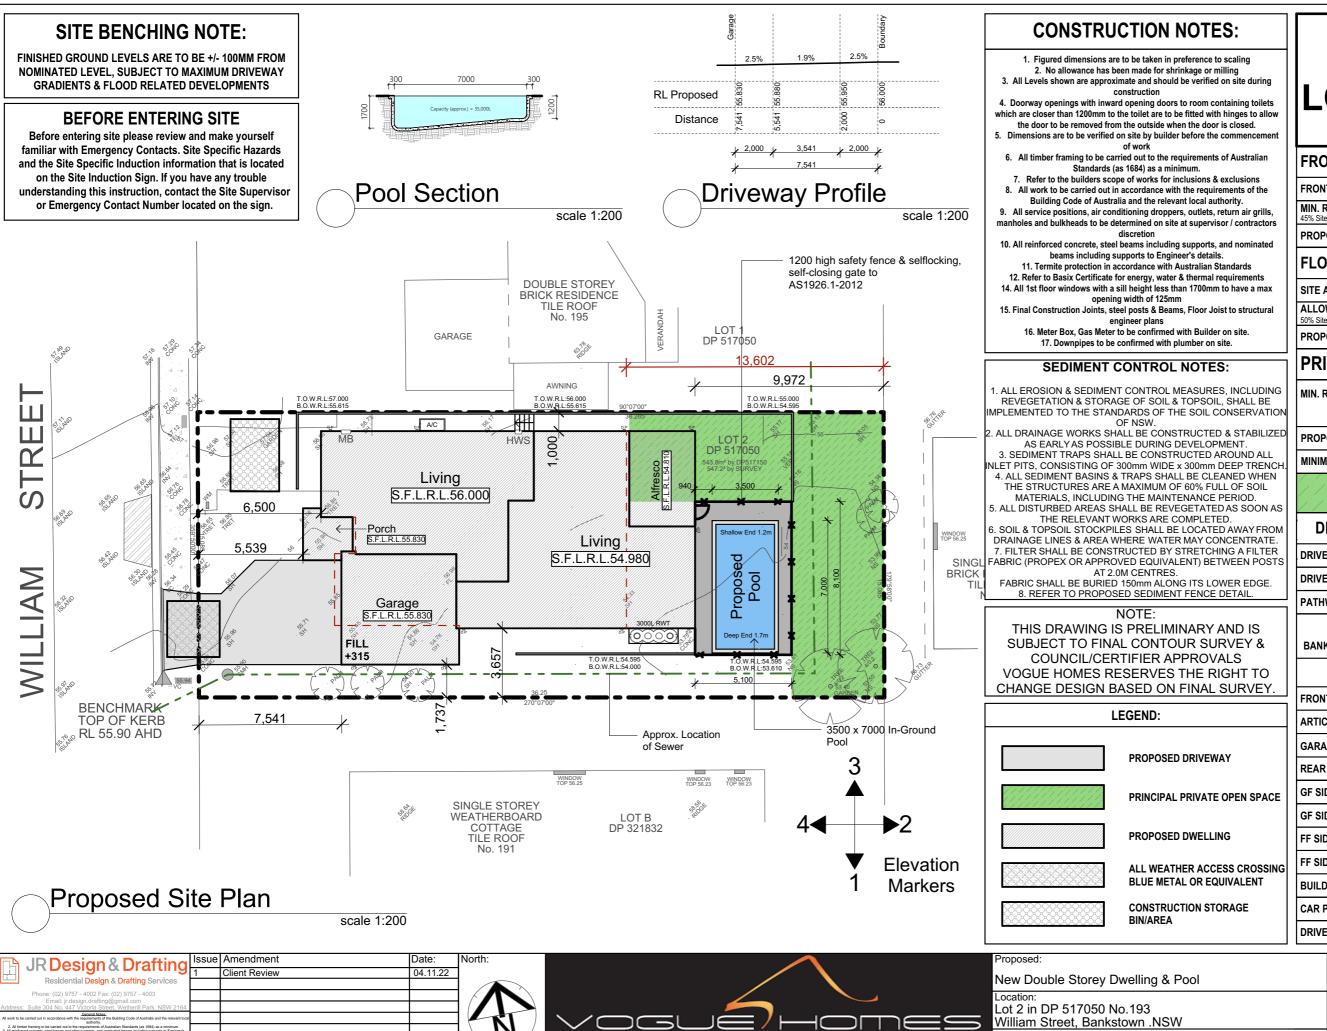

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D.A LODGEMENT

FRONT LANDSCAPE AREA

PROPOSED LANDSCAPE AREA	51.00m ²
MIN. REQUIRED 45% Site Area	44.05m ²
FRONT SETBACK AREA	97.90m ²

FLOOR SPACE RATIO

SITE AREA	547.20m ²
ALLOWED: 50% Site Area	273.60m ²
PROPOSED AREA	273.32m²

PRIVATE OPEN SPACE

MIN. REQUIRED 80.00m²

PROPOSED AREA 120.00m²

MINIMUM 5.0M X 5.0M YES

PRINCIPAL PRIVATE OPEN SPACE

DRIVEWAY / PATHWAY AREAS

DRIVEWAY CROSSOVER AREA:	7.50m ²
DRIVEWAY AREA:	38.00m ²

DRIVEWAY AREA:

PATHWAY AREA: N/A

COMPLIANCE TABLE

BANKSTOWN DEVELOPMENT CONTROL PLAN 2015

CRITERIA	ALLOWED/ REQUIRED	PROPOSED
FRONT SETBACK:	6.5M	6.50M
ARTICULATION ZONE:	6.0M	6.019M
GARAGE SETBACK:	7.5M	7.541M
REAR SETBACK:	0.9M GF 0.9M FF	9.972M 13.602M
GF SIDE SETBACK (A):	0.9M	1.0M
GF SIDE SETBACK (B):	0.9M	1.737M
FF SIDE SETBACK (A):	0.9M	1.0M
FF SIDE SETBACK (B):	0.9M	3.657M
BUILDING HEIGHT:	9.00M	9.00M
CAR PARKING SPACES:	2 SPACES	2 SPACES
DRIVEWAY WIDTH:	4.5M	4.2M

CALDORA 40

9101-22

VH2249

VH Job No:

JR Job No:

04.11.22

3 of 15


Proposed Site Plan

FREMANTLE

1:200

Joseph Anthony Latorre & Marilyn Nguyen

Bankstown Council

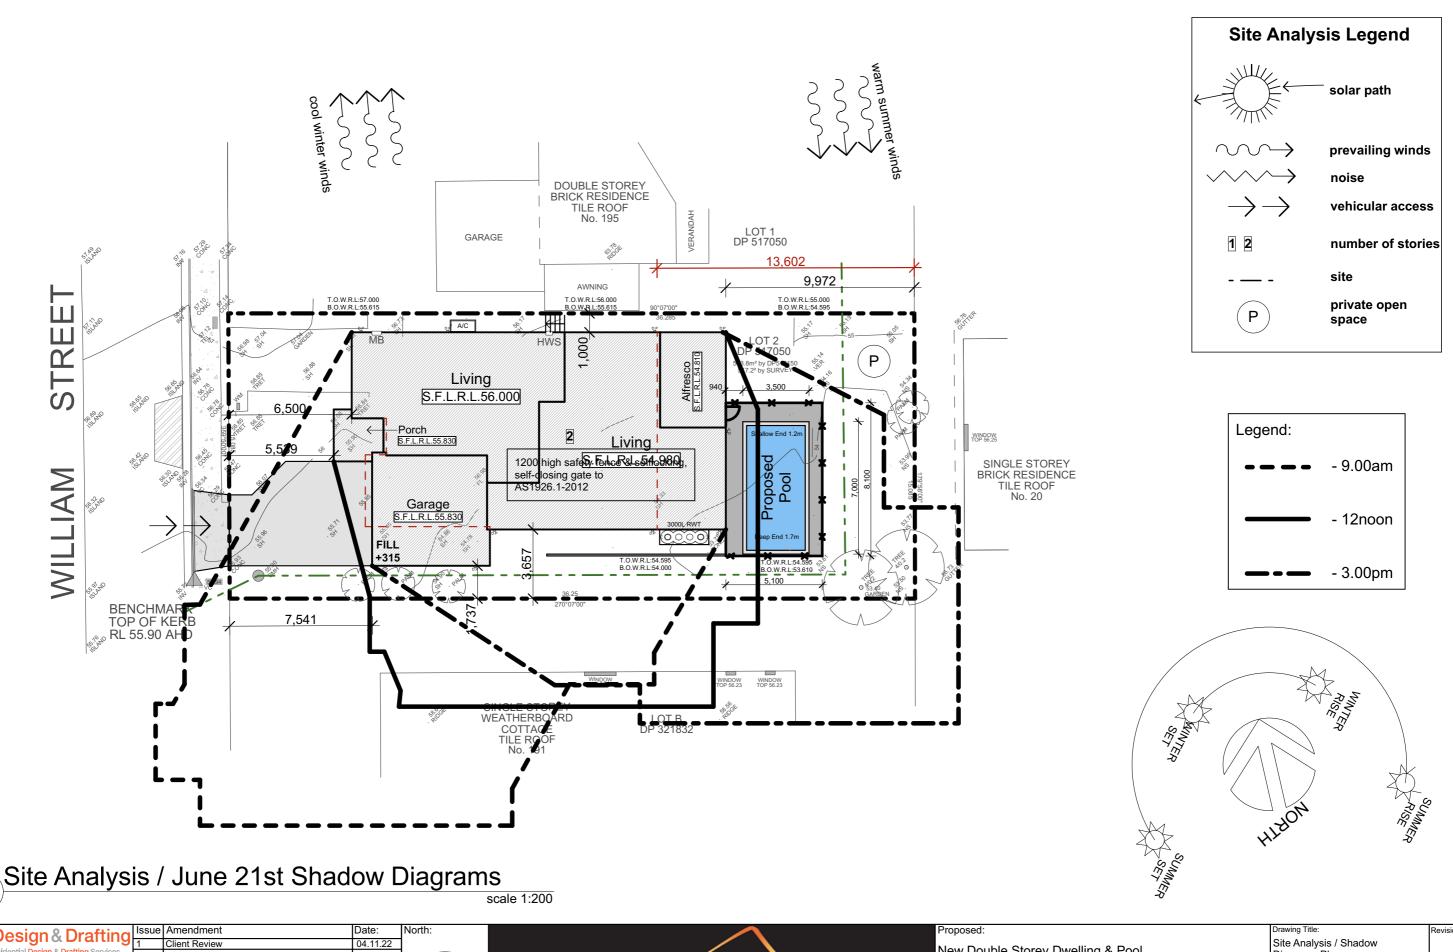

| Second State | Seco




- 1. ALL EROSION & SEDIMENT CONTROL MEASURES, INCLUDING REVEGETATION & STORAGE OF SOIL & TOPSOIL, SHALL BE IMPLEMENTED TO THE STANDARDS OF THE SOIL CONSERVATION OF NSW.
- 2. ALL DRAINAGE WORKS SHALL BE CONSTRUCTED & STABILIZED AS EARL' AS POSSIBLE DURING DEVELOPMENT. 3. SEDIMENT TRAPS SHALL BE CONSTRUCTED AROUND ALL INLET PITS,
- CONSISTING OF 300mm WIDE x 300mm DEEP TRENCH.
 4. ALL SEDIMENT BASINS & TRAPS SHALL BE CLEANED WHEN THE STRUCTURES ARE A MAXIMUM OF 60% FULL OF SOIL MATERIALS,
- INCLUDING THE MAINTENANCE PERIOD.


 5. ALL DISTURBED AREAS SHALL BE REVEGETATED AS SOON AS THE RELEVANT WORKS ARE COMPLETED.
- 6. SOIL & TOPSOIL STOCKPILES SHALL BE LOCATED AWAY FROM DRAINAGE LINES & AREA WHERE WATER MAY CONCENTRATE.
- 7. FILTER SHALL BE CONSTRUCTED BY STRETCHING A FILTER FABRIC (PROPEX OR APPROVED EQUIVALENT) BETWEEN POSTS AT 2.0M CENTRES. FABRIC SHALL BE BURIED 150mm ALONG ITS LOWER EDGE.


Erosion Control


Temporary sediment and erosion control and measures are to be installed prior to commencement of any worls on the site. these measures must be maintained in working order during construction works up to completion. All sediment traps must be cleared on a regular basis and after major storm and/or as directed by the Principal Certifying Authority and Council officers.


PROOF OF EXISTENCE OF ALL SERVICES IS THE CONTRACTOR'S RESPONSIBILITY. CURRENT "DIAL BEFORE YOU DIG" SERIVCES PLANS MUST BE OBTAINED PRIOR TO COMMENCING ANY EXCAVATION.

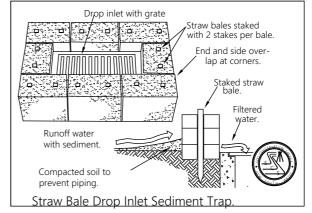


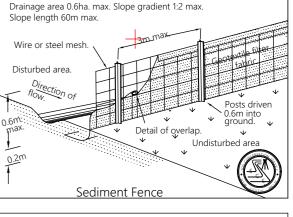

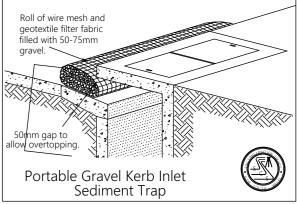

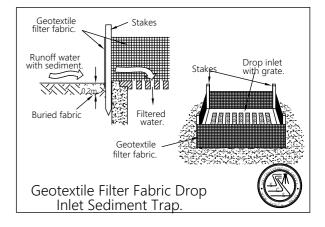

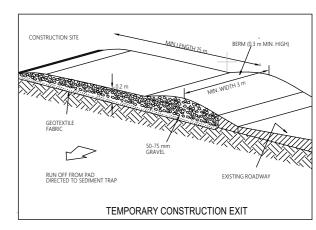

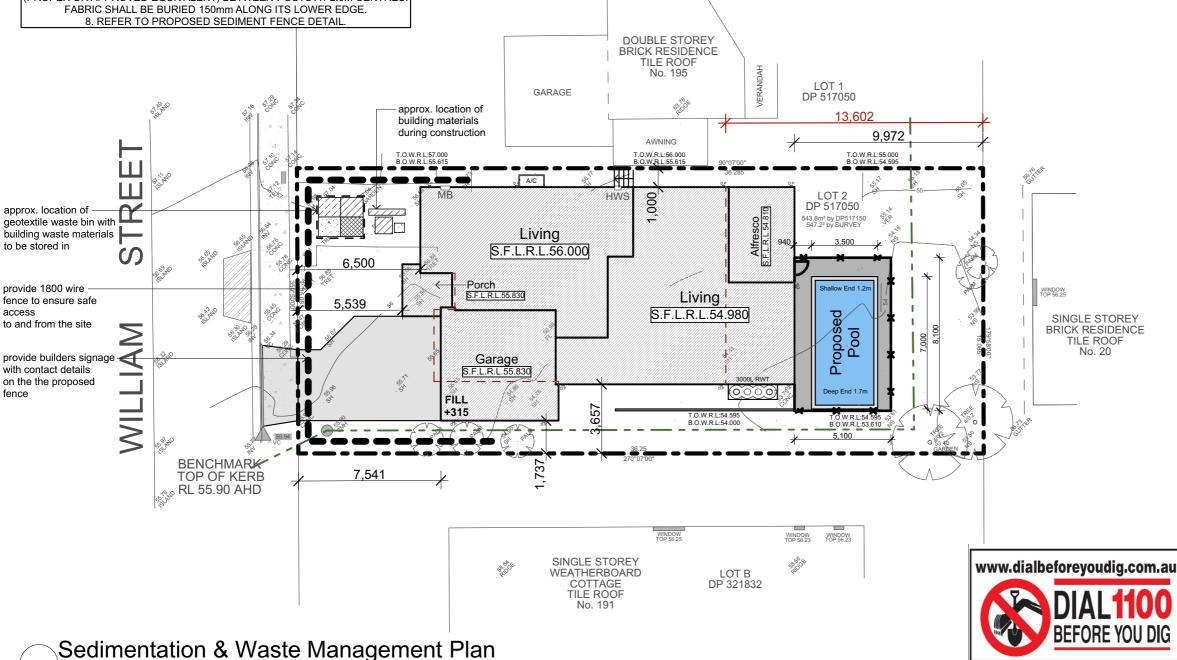



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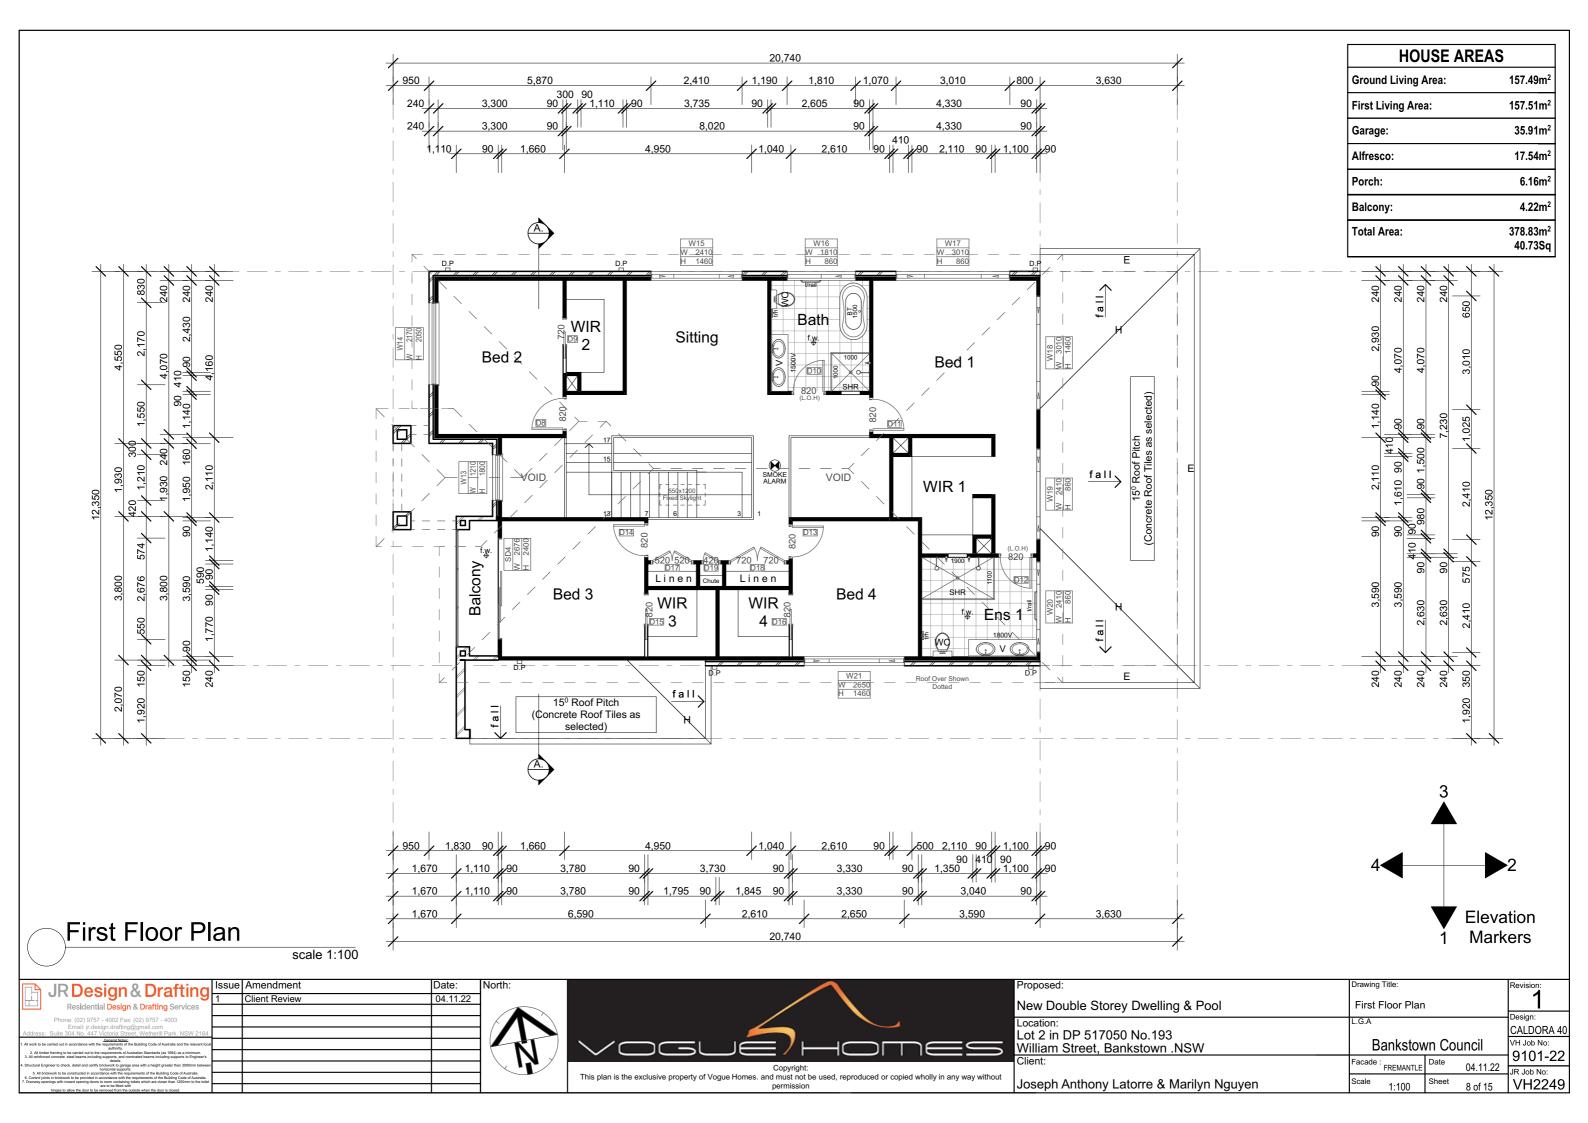





Proposed:	Drawing Title:	Revision:
Marris Davidala Otamari Diviall'in n O Da al	Soil Sedimentation & Waste Management	Design:
Location.	L.G.A	CALDORA 40
Lot 2 in DP 517050 No.193		VH Job No:
William Street, Bankstown .NSW	ı Dankəluwii Guundi i	9101-22
Client:	Facade: EDEMANITIE Date 0/ 11 22	
		JR Job No:
Joseph Anthony Latorre & Marilyn Nguyen	Scale 1:200 Sheet 5 of 15	VH2249




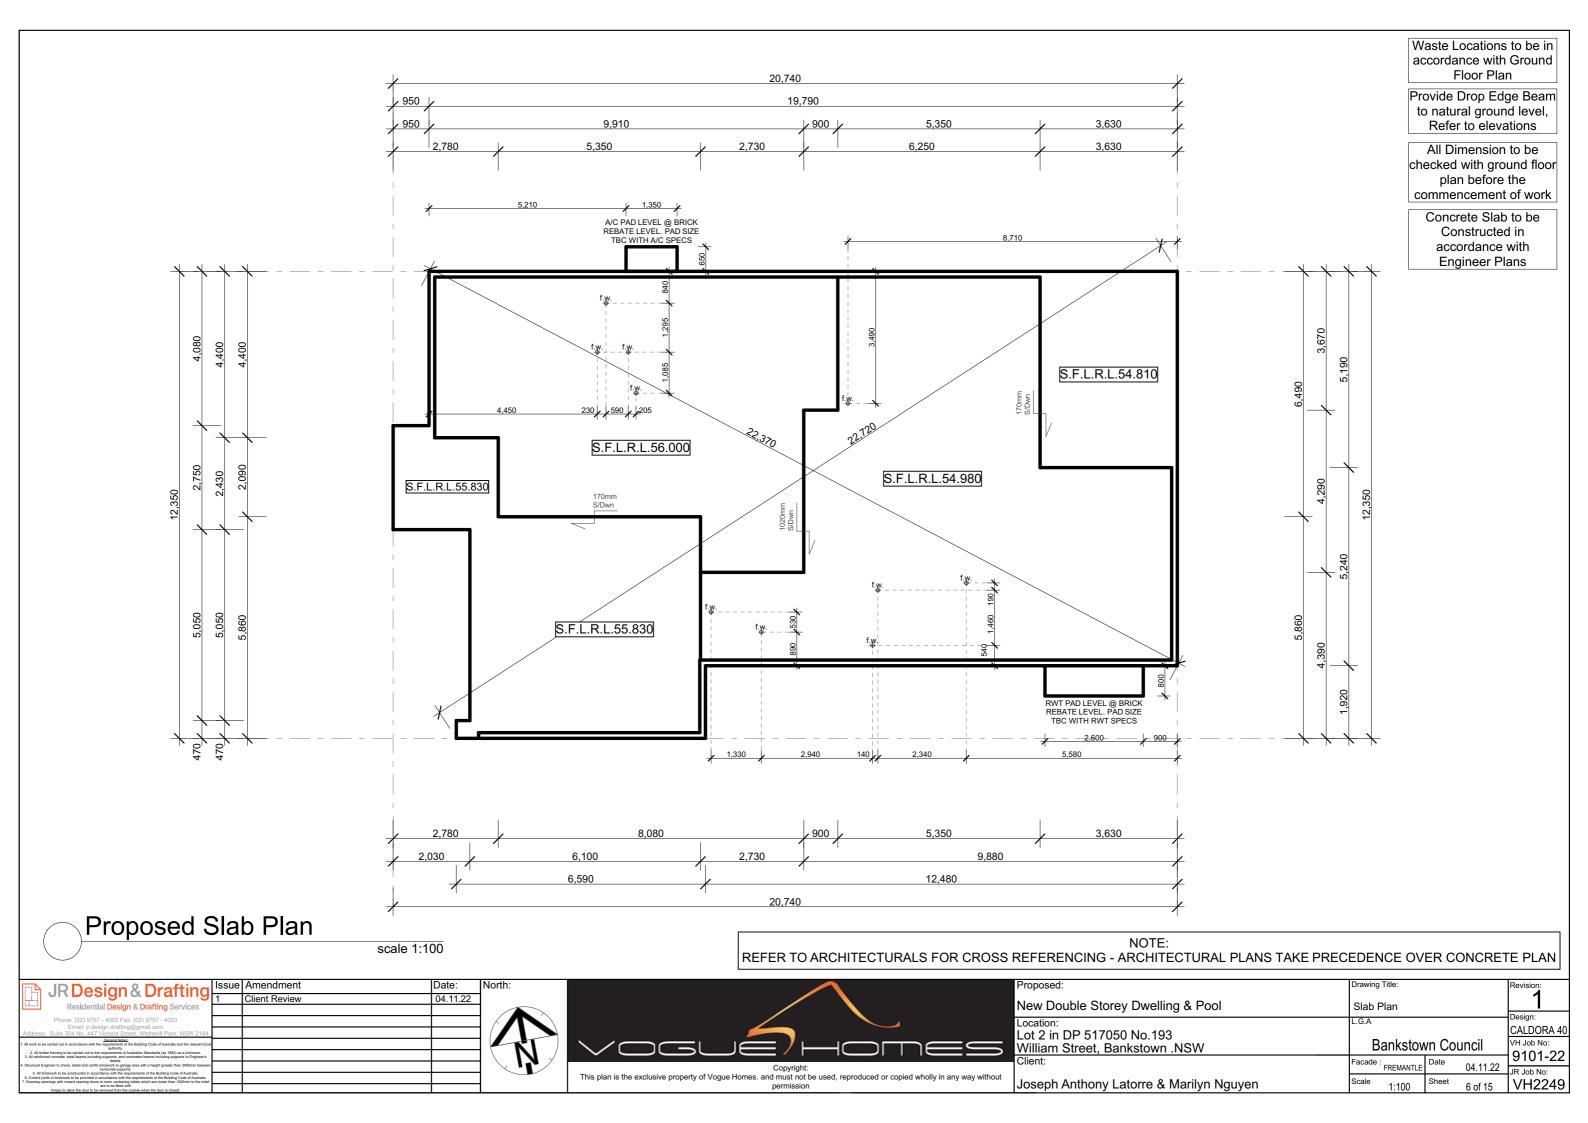

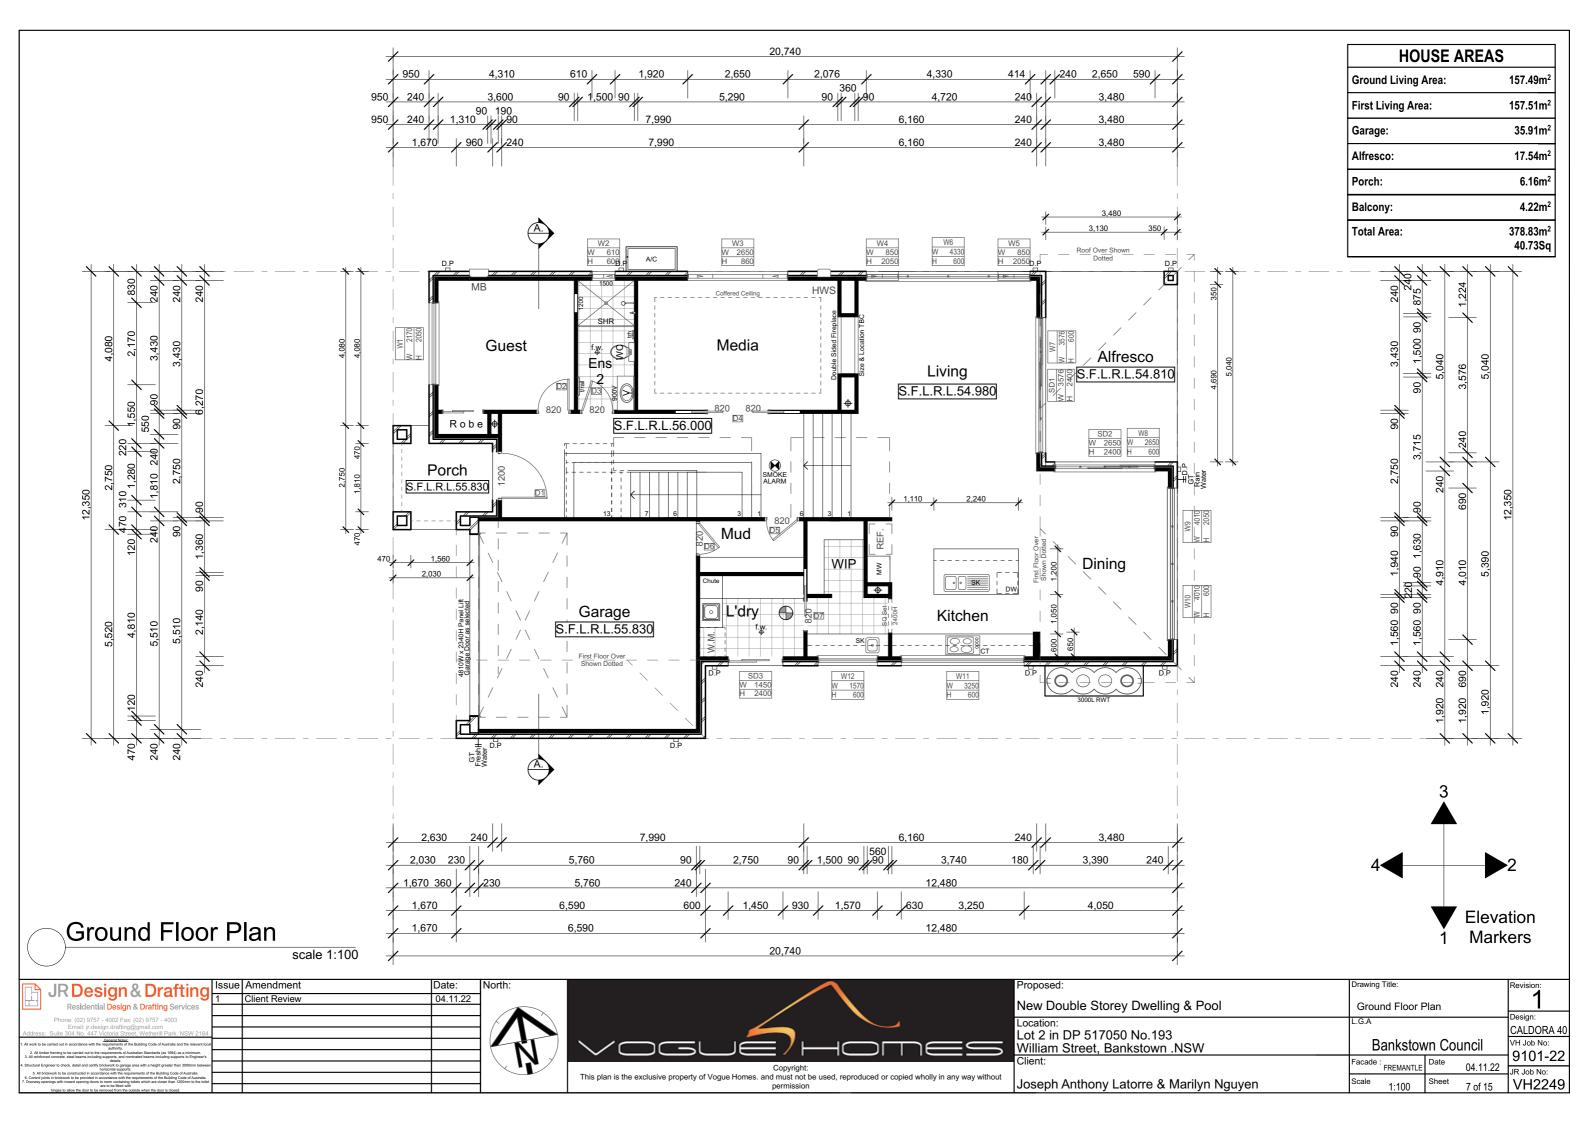

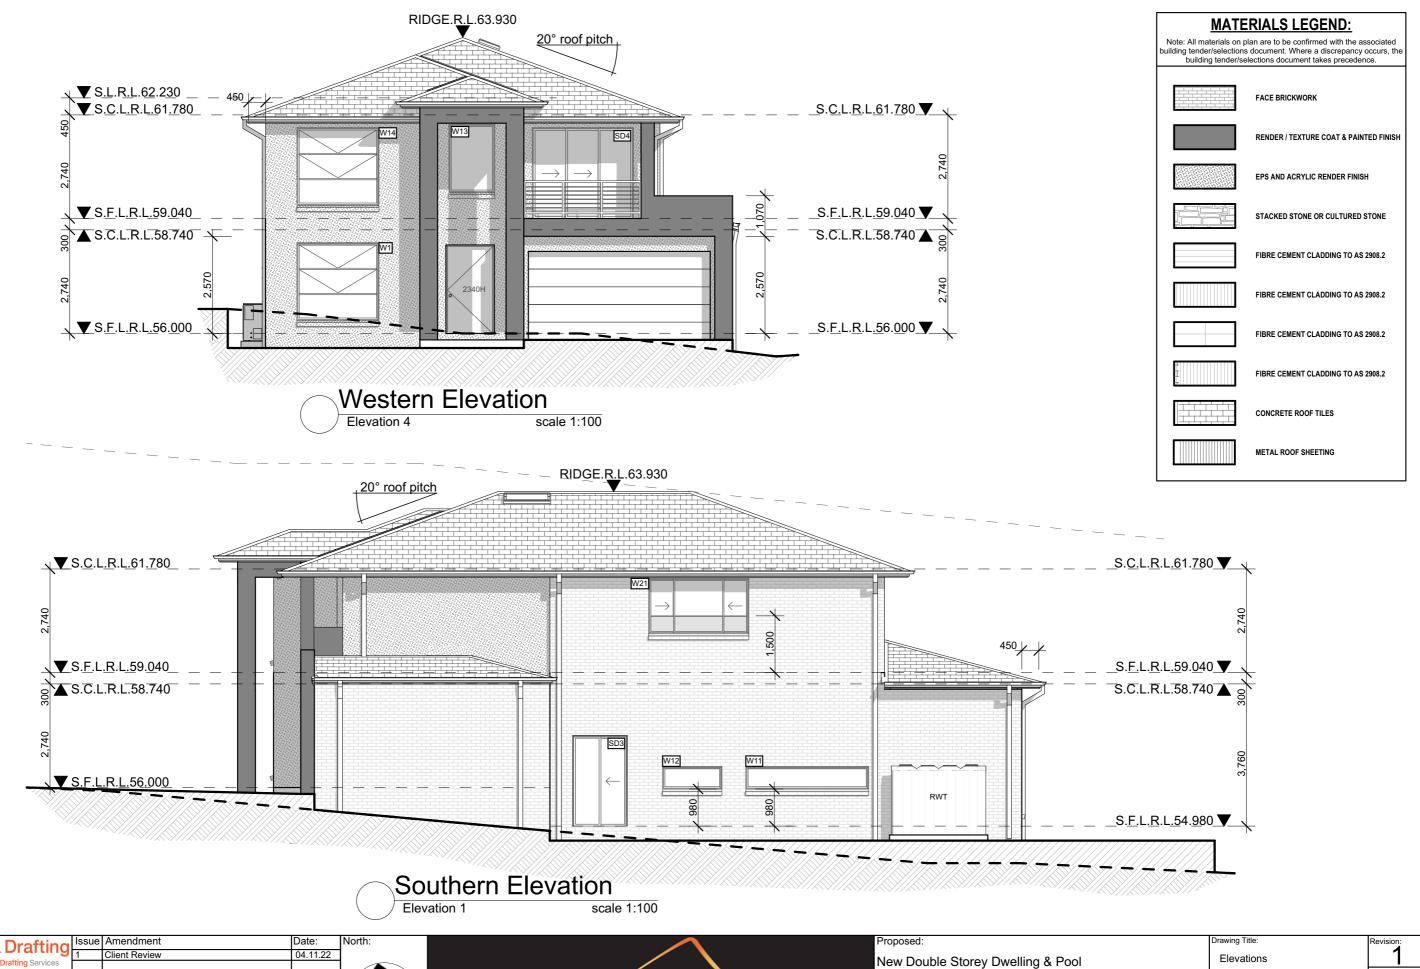

lг	A IR Design & Drafting	Issue Amendment	Date:	North:		Proposed:	Drawing Title:	Revision:	
	Residential Design & Drafting Services	1 Client Review	04.11.22			New Double Storey Dwelling & Pool	Elevations	1	_
A	Phone: (02) 9757 - 4002 Fax: (02) 9757 - 4003 Email: jr.design.drafting@gmail.com ddress: Suite 304 No. 447 Victoria Street, Wetherill Park. NSW 2164					Location: Lot 2 in DP 517050 No.193	L.G.A	CALDORA 40	J
1.7	Il work to be carried out in accordance with the requirements of the Building Code of Australia and the relevant local authority. 2. All imber farming to be carried out to the requirements of Australian Standanck (as 1684) as a minimum. All all secretories of Australian Standanck (et differencements of Australian Standanck (et differencements of Australian Standanck).			KI	VOGUÉ/HOMES	William Street, Bankstown .NSW		VH Job No: 9101-22	,]
4.1	details. Itructural Engineer to check, detail and cently brickwork to garage area with a height greater than 3000mm between horizontal supports. 5. All brickwork to be constructed in accordance with the requirements of the Building Code of Australia.			14	Copyright: This plan is the exclusive property of Vogue Homes. and must not be used, reproduced or copied wholly in any way without	Client:	Facade: FREMANTLE Date 04.11.22	JR Job No:	1
7.	1. Control joints in britished to be priviled in a doctreamer with the requirements or the suiting Code or Australia. Docrowy openings with inseed opening doors to come containing tables which are closer than 1200mm to the tablet hinges to allow the door to be removed from the outside when the door is closed.			1	permission	Joseph Anthony Latorre & Marilyn Nguyen	Scale 1:100 Sheet 9 of 15	VH2249	

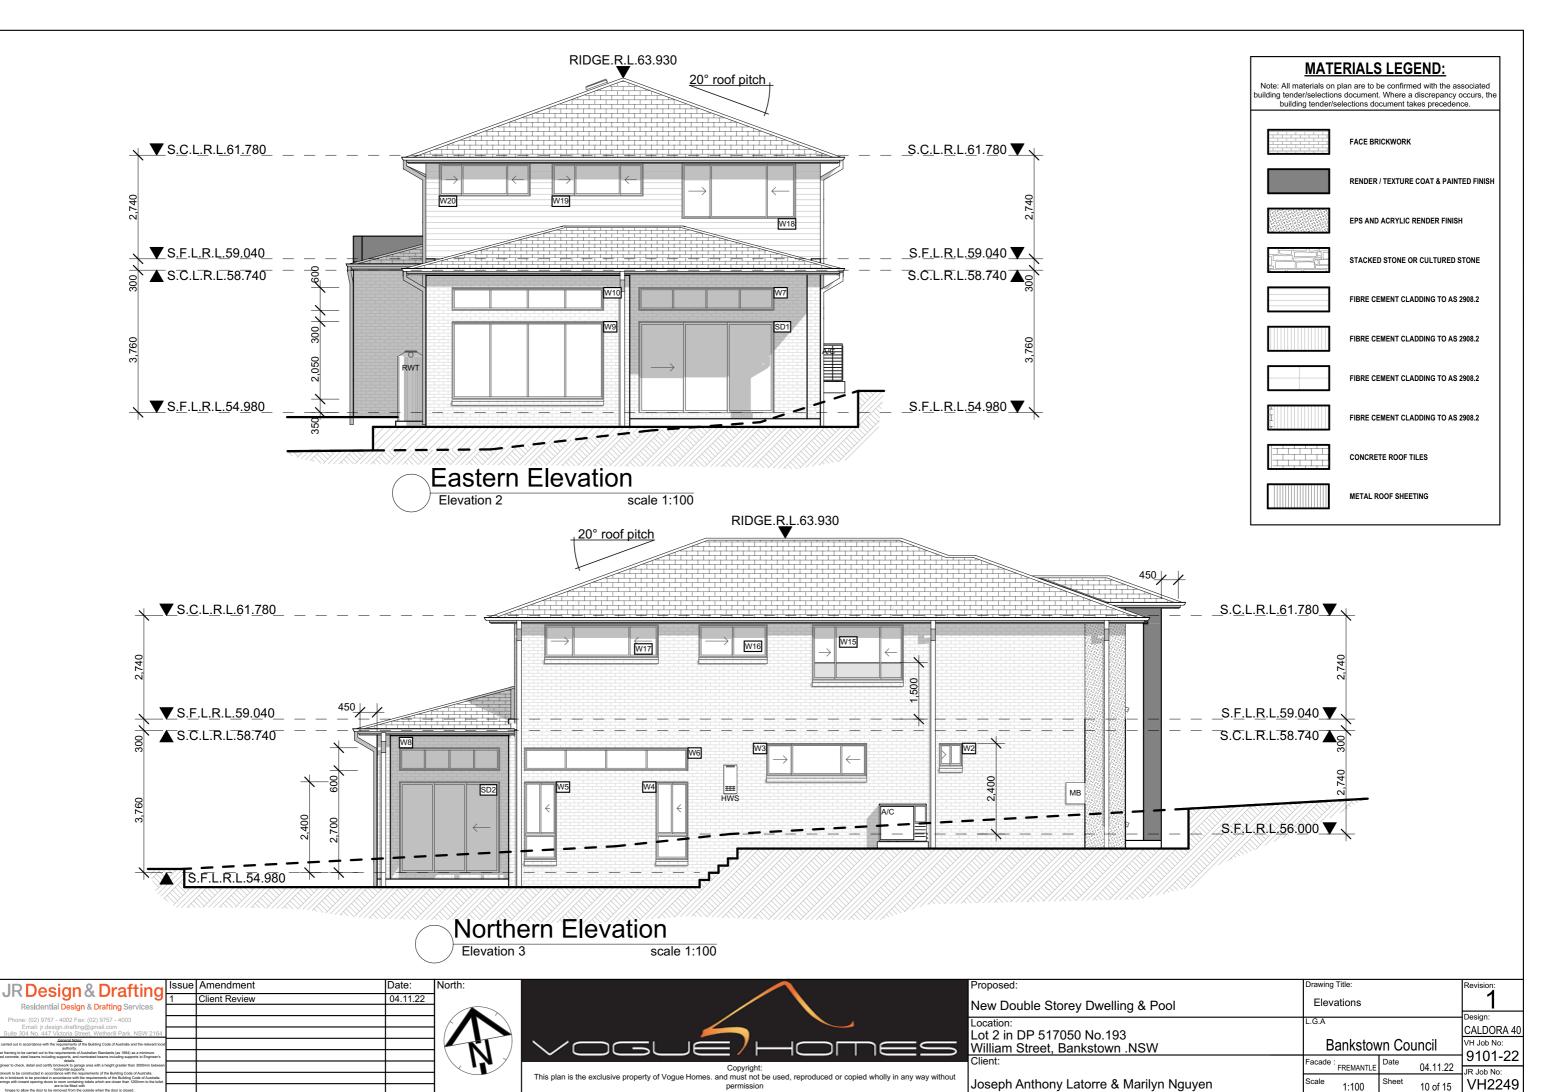

Door Schedule DOOR HEIGHT MATERIAL **NUMBER** (mm) (mm) D1 2340 1200 External Entry Solid D2 2340 820 Internal Hollow Core D3 2340 820 Internal Hollow Core 2340 D4 1640 Internal Double Cavity Sliding Hollow Core D5 2340 820 Internal Hollow Core 820 D6 2340 Hollow Core D7 2340 820 Internal Cavity Sliding Hollow Core D8 2340 820 Hollow Core Internal D9 2340 720 Internal Cavity Sliding Hollow Core D10 2340 820 Internal Hollow Core D11 2340 820 Internal Hollow Core D12 2340 820 Internal Hollow Core D13 2340 820 Internal Hollow Core D14 2340 820 Internal Hollow Core D15 2340 820 Internal Cavity Sliding Hollow Core D16 2340 820 Hollow Core D17 2340 1040 Internal Double Hollow Core

All Doors to be checked in conjunction with Signed Building Tender Where a discrepancy occurs, the building tender/selections document takes precedence.

Internal Double

External Sliding

External Stacker Sliding

External Stacker Sliding

External Stacker Sliding

Internal

Hollow Core

Hollow Core

Aluminium

Aluminium

Aluminium

Aluminium

D18

D19

SD1

SD2

SD3

SD4

2340

2340

2400

2400

2400

2400

1040

420

3576

2650

1450


2676

Window Schedule

WINDOW NUMBER	HEIGHT (mm)	WIDTH (mm)	COMMENT	REVEAL
W1	2050	2170	Aluminium Awning	Brick Veneer
W2	600	610	Aluminium Sliding Obscure	Brick Veneer
W3	860	2650	Aluminium Sliding	Brick Veneer
W4	2050	850	Aluminium Sliding	Brick Veneer
W5	2050	850	Aluminium Sliding	Brick Veneer
W6	600	4330	Aluminium Fixed	Brick Veneer
W7	600	3576	Aluminium Fixed	Brick Veneer
W8	600	2650	Aluminium Fixed	Brick Veneer
W9	2050	4010	Aluminium Fixed	Brick Veneer
W10	600	4010	Aluminium Fixed	Brick Veneer
W11	600	3250	Aluminium Fixed	Brick Veneer
W12	600	1570	Aluminium Fixed	Brick Veneer
W13	1800	1210	Aluminium Fixed	Brick Veneer
W14	2050	2170	Aluminium Awning	Brick Veneer
W15	1460	2410	Aluminium Sliding	Brick Veneer
W16	860	1810	Aluminium Sliding Obscure	Brick Veneer
W17	860	3010	Aluminium Sliding	Brick Veneer
W18	1460	3010	Aluminium Sliding	Cladding
W19	860	2410	Aluminium Sliding	Cladding
W20	860	2410	Aluminium Sliding Obscure	Cladding
W21	1460	2650	Aluminium Sliding Obscure	Brick Veneer

Note:

^{*} All Bedroom Windows with a floor level more than 2 meters from natural ground level must be fitted with a device to restrict the window opening, or a suitable screen, so a 125mm diameter sphere cannot pass through. The device of screen must also be able to withstand an outward horizontal force of 250 N. ALL FIRST FLOOR WINDOWS TO BE FITTED WITH RESTRICTORS

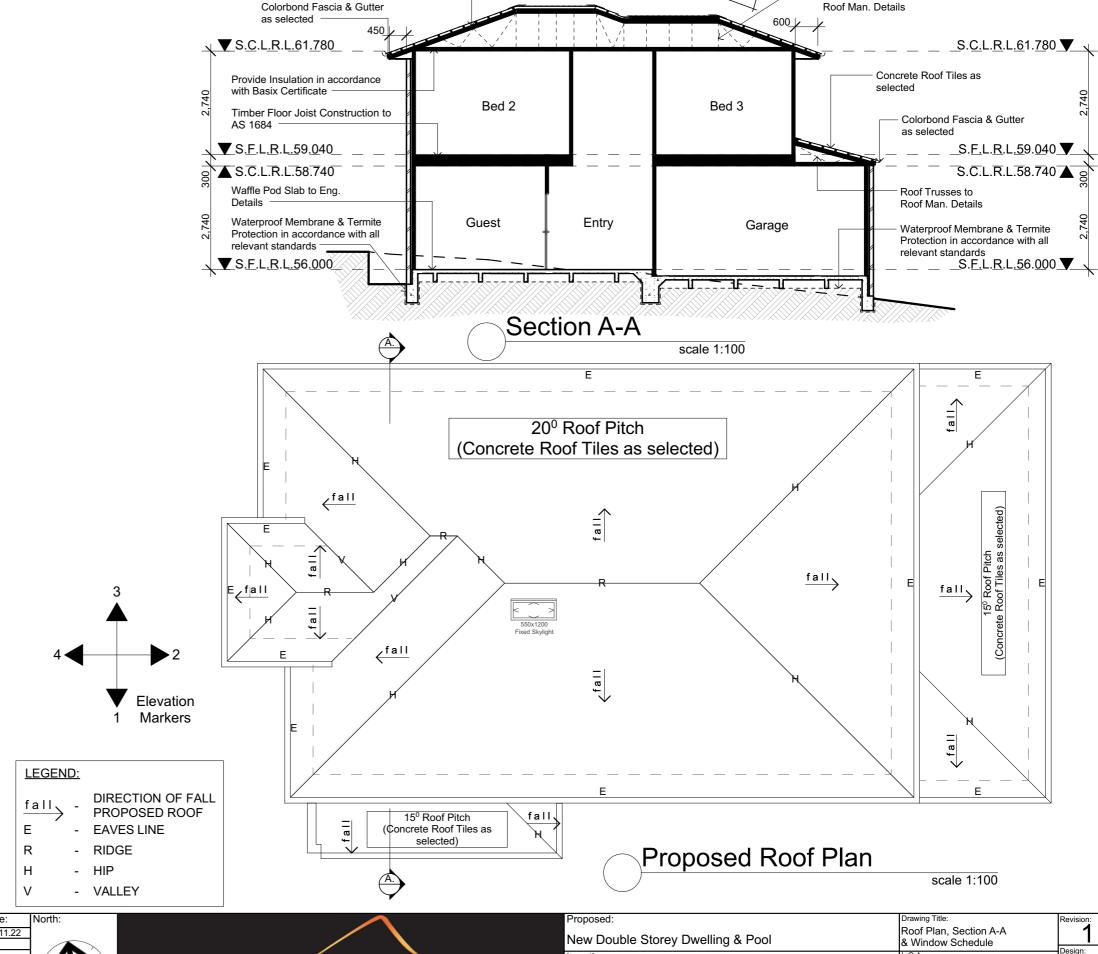


20° roof pitch

Roof Trusses to

Roof Man. Details


Concrete Roof Tiles as

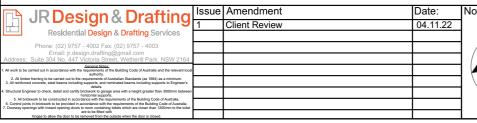





Proposed:	Drawing Title:			Revision:
	Roof Plan, Section A-A & Window Schedule		1	
-	L.G.A			Design:
Location.				CALDORA 40
Lot 2 in DP 517050 No.193 William Street, Bankstown .NSW	Bankstown Council		VH Job No:	
Client:	Facade : FREMANTLE	Date	04 44 00	9101-22
	FREMANILE		04.11.22	JR Job No:
Joseph Anthony Latorre & Marilyn Nguyen	Scale 1:100	Sheet	11 of 15	VH2249

STANDARD PC ITEM FIXING HEIGHTS SHOWN AS A GUIDE ONLY - TO BE CONFIRMED BY SELECTIONS OR ON SITE BY SUPERVISOR

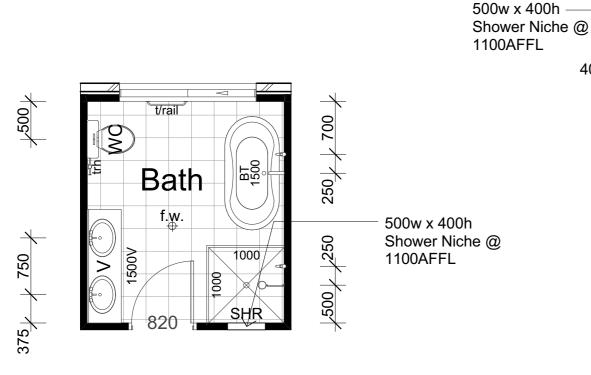


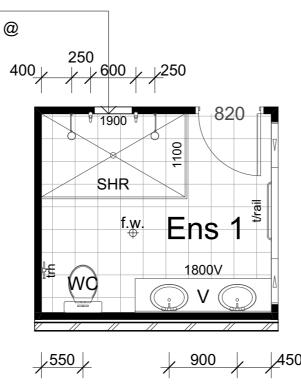

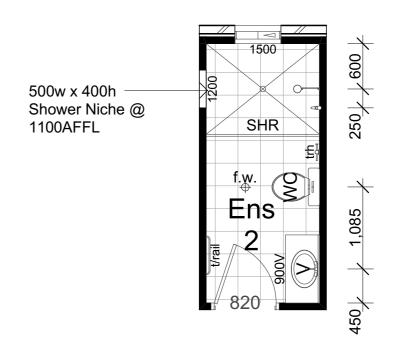

Bathroom Detail scale 1:50 Ens 1 Detail scale 1:50



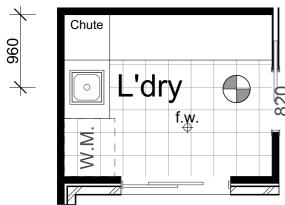

L'dry Detail scale 1:50

STANDARD BATHROOM PC ITEMS FIXING HEIGHTS

Note: Guide only, to be confirmed by selections and/or supervisor on site

TOWEL RAIL: 1100 ABOVE FFL or 1700 IF OVER BATH **TOWEL RING:** 1100 ABOVE FFL

or 1400 IF OVER VANITY DRAWERS


TOILET ROLL HOLDER: 600 ABOVE FFL SHOWER HEAD: 1900 ABOVE FFL SHOWER MIXER: 1050 ABOVE FFL **BATH SPOUT:** 700 ABOVE FFL BATH MIXER: 700 ABOVE FFL

WALL HUNG VANITY: 900 TO TOP OF VANITY/BOWL or

ALIGN WITH OTHER FLOOR STANDING UNITS or

ALIGN WITH NEAREST TILE LINE



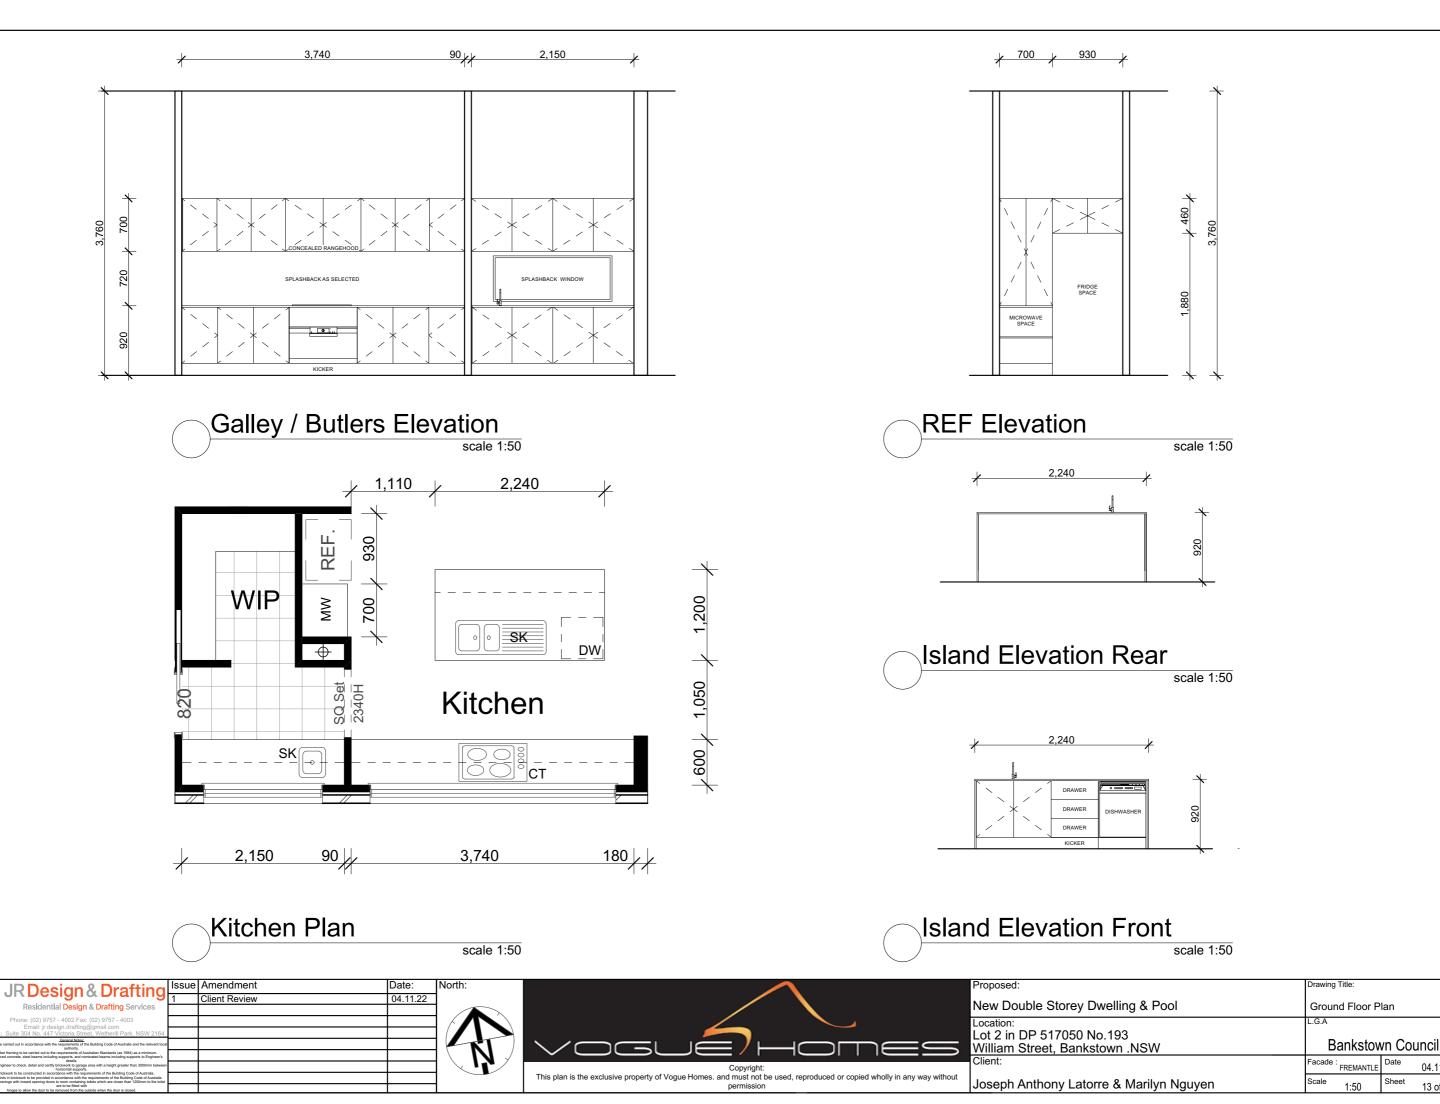


CALDORA 40

VH Job No: 9101-22

JR Job No: 13 of 15 VH2249

04.11.22

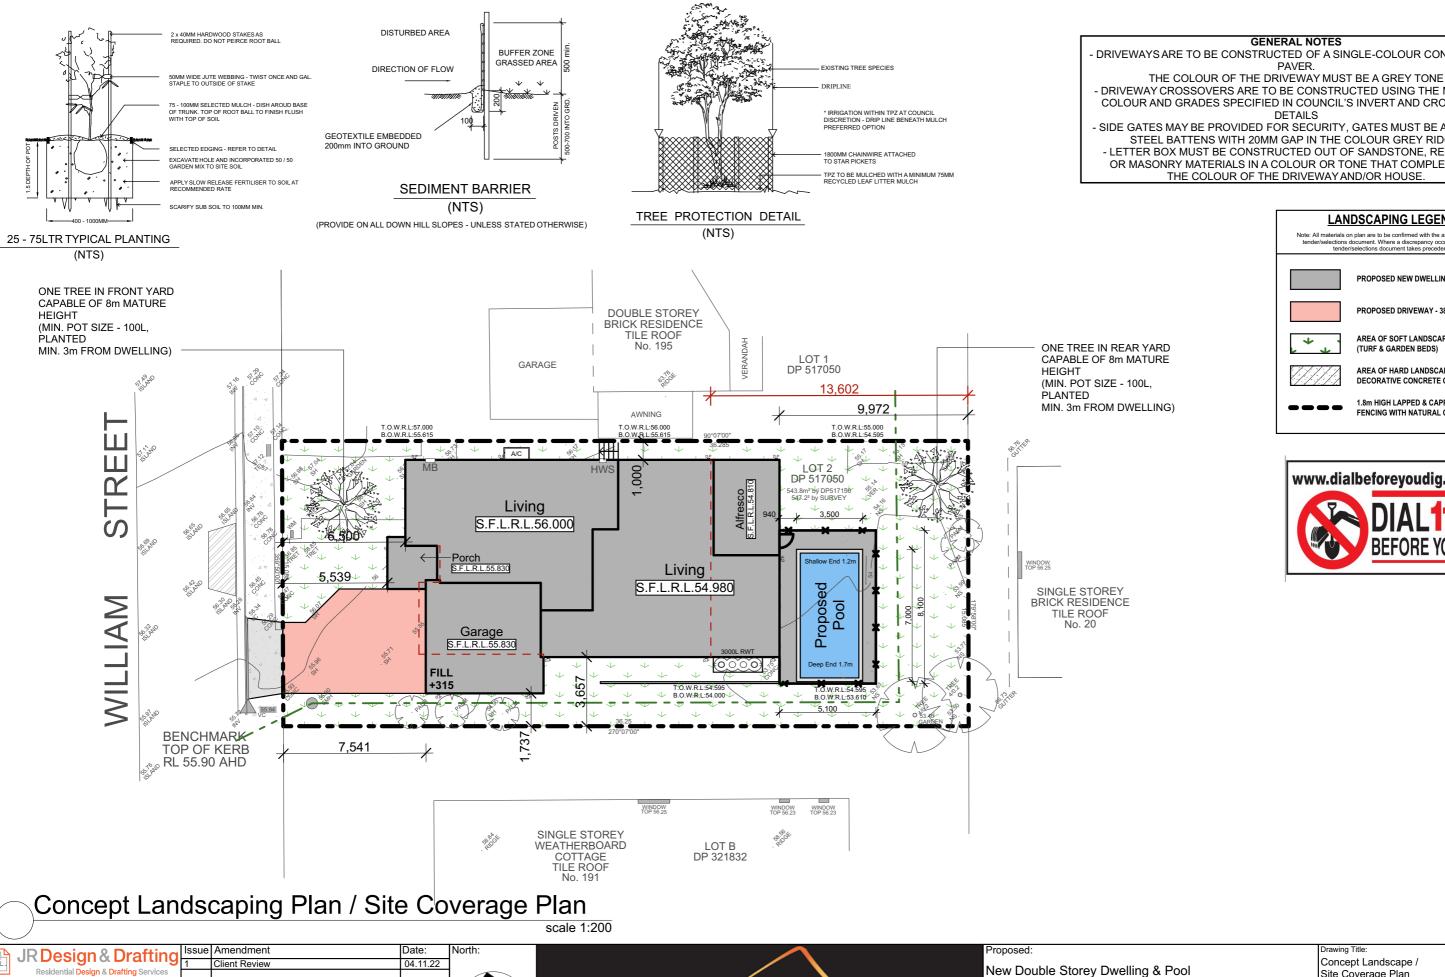

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GENERAL NOTES

- DRIVEWAYS ARE TO BE CONSTRUCTED OF A SINGLE-COLOUR CONCRETE OR PAVER.
- DRIVEWAY CROSSOVERS ARE TO BE CONSTRUCTED USING THE MATERIAL, COLOUR AND GRADES SPECIFIED IN COUNCIL'S INVERT AND CROSSOVER **DETAILS**
- SIDE GATES MAY BE PROVIDED FOR SECURITY, GATES MUST BE ALUMINIUM STEEL BATTENS WITH 20MM GAP IN THE COLOUR GREY RIDGE.
- LETTER BOX MUST BE CONSTRUCTED OUT OF SANDSTONE, RENDERED OR MASONRY MATERIALS IN A COLOUR OR TONE THAT COMPLEMENTS THE COLOUR OF THE DRIVEWAY AND/OR HOUSE.

LANDSCAPING LEGEND:

Note: All materials on plan are to be confirmed with the associated building tender/selections document. Where a discrepancy occurs, the building tender/selections document takes precedence.

PROPOSED NEW DWELLING



PROPOSED DRIVEWAY - 38.00m²



AREA OF SOFT LANDSCAPING (TURF & GARDEN BEDS)



AREA OF HARD LANDSCAPING (PAVERS, DECORATIVE CONCRETE OR SIMILAR)



1.8m HIGH LAPPED & CAPPED TIMBER

FENCING WITH NATURAL OR CLEAR FINISH



Concept Landscape /

acade : FREMANTLE Date

1:200

Bankstown Council

CALDORA 40

9101-22

VH Job No:

JR Job No:

14 of 15 VH2249

04.11.22


Site Coverage Plan


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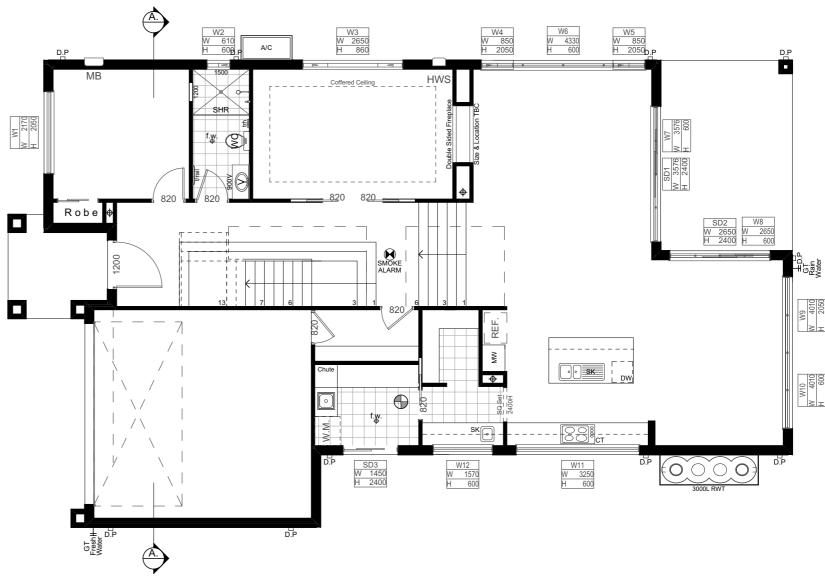
Lot 2 in DP 517050 No.193


William Street, Bankstown .NSW

Joseph Anthony Latorre & Marilyn Nguyen



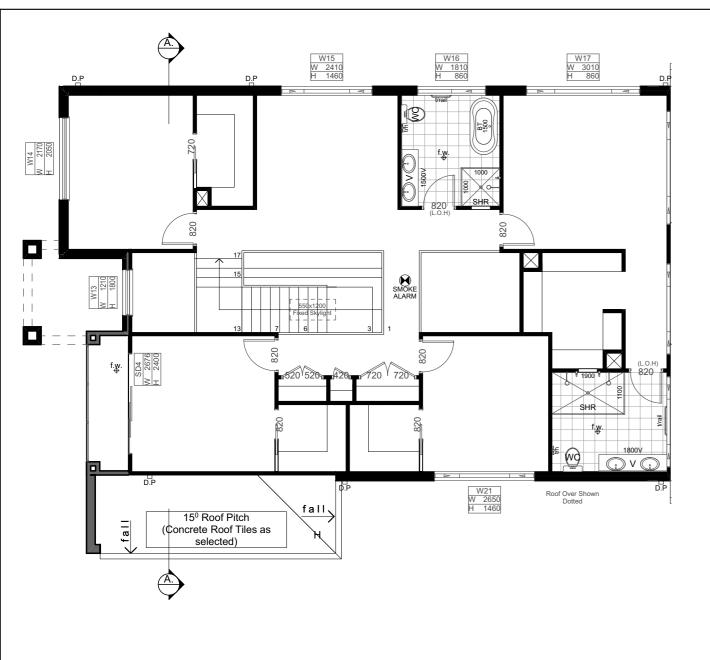

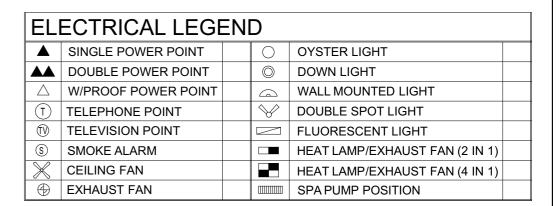

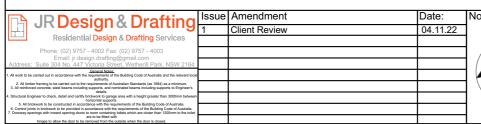



Proposed:	Drawing Title:			Revision:
New Double Storey Dwelling & Pool	Electrical Plan		1	
Location: Lot 2 in DP 517050 No.193	L.G.A			Design: CALDORA 40
William Street, Bankstown .NSW	Bankstown Council			VH Job No:
Client:	Facade : FREMANTLE	Date (04.11.22	9101-22 JR Job No:
Joseph Anthony Latorre & Marilyn Nguyen	Scale 1:100	Sheet ,	15 of 15	VH2249